
ABBREVIATIONS ELECT ELEV ENCL ENGR EQ EST EXIST EXT above above finish floor above sub floor F/ F.D. FDN FF FIN FLR FRT FS FTG FV FBGLS face of floor drain foundation finished floor finish (ed) BTWN BLDG BLK BLKG BRK BSMT G&N GA GALV GC GL GWB GWB/X glue & nail gauge galvanized general contractor glass on center octagonal outside diamete overhead opening opposite optional original pounds per cubic foot plate plumbing plumber pounds per linear foot parallel plastic laminate TC TEL T & G TH TLT TV TYP PL. LAM PLYWD PSF PSI PT P.T. CONT CONTR CPT pounds per square foot pounds per square inch point preservative treated contract (or) carpet ceramic tile cable tv cubic UL underwriters laboratories UNO unless noted otherwise D DBL DET DF vapor barrier vapor retarder vinyl composition tile vertical QT quarry tile JT VERT length laminate lavatory pound left hand DR DR DSP DW DWG wire glass wall hung long leg vertical living room light laminated veneer lumber drawing NOTE: CONTRACTOR MUST REQUEST ARCHITECT'S INTERPRETATION OF ANY OTHER ABBREVIATIONS USED ON THESE DRAWINGS BEFORE PROCEEDING

ARCHITECTURAL SYMBOLS

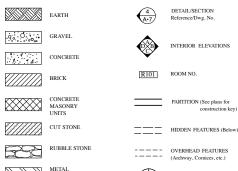

METAL (large scale)

PLYWOOD (large scale)

BLOCKING

IMAGE

FINISHED WOOD

WOOD FRAMING (ROUGH)

RIGID INSULATION















LIST OF DRAWINGS

- T-1 Title Sheet
- A-0 Basement Plan
- A-1 First Floor Plan
- A-2 Second Floor Plan
- A-3 Third, Fourth & Tower Roof Plans
- A-4 Building Sections
- A-5 East & North Elevations
- A-6 West & South Elevations
- A-7 Window & Room Rehabilitation Schedules
- A-8 Roof Details

STABILIZATION & RESTORATION PLANS FOR THE

MOHONK PRESERVE TESTIMONIAL GATEWAY

NEW PALTZ, NEW YORK

OWNER:

MOHONK PRESERVE, INC. P.O. BOX 715 NEW PALTZ, NEW YORK 12569

ARCHITECT:

CRAWFORD & STEARNS ARCHITECTS AND PRESERVATION PLANNERS 134 WALTON STREET SYRACUSE, NEW YORK 13202

ARCHITECT'S PROJECT NUMBER: 1502


DATE: MAY, 2015

TYPICAL NOTES

- All Contractors must verify all field conditions & dimensions prior to commencement of the work of the contract & coordinate accordingly. Notify the architect promptly of any inconsistencies or conditions which could contribute to a material change in the scope or execution of the work as defined by the contract document.
- 2. Unless otherwise specifically indicated, all work for which a building permit is issued shall comply with all applicable portions of the Building Code of New York State, the Residential Code of New York State, the Residential Code of New York State, the Purphing Code of New York State, the Property Maintenance Code of New York State, the Fire Code of New York State, and The State, the Fire Code of New York State, and The State, the Fire Code of New York State, and all supplementary codes and standards referenced therein. In the event that multiple codes apply, including any applicable local ordinances, the Contractor shall comply with the most stringent requirements.
- 3. In the event of inconsistencies in the contract documents or of inadequate information, consult with the Architect.
- Provide labor, material, equipment and services required to execute and complete all items of work as shown or indicated on the drawings and as specified herein, including incidental items to effect a finished and complete job, even though such items are not shown or particularly mentioned.
- Structural work, including material stresses and methods of construction, shall be in compliance with the New York State Fire Prevention and Building Code, the Uniform Building Code, OSHA and governing agencies having jurisdiction.
- 6. Contractor shall be responsible for shoring and temporary supports. All means, methods, scheduling and sequencing of work shall be the responsibility of the Contractor. Shoring and temporary support of structure and any engineering costs associated with it to facilitate completing of the work of this contract are the responsibility of the Contractor.
- 7. Contractor shall use construction methods that are in strict accordance with manufacturer's specifications.
- 8. Centerline of footings, walls, grade beams, columns, and beams shall coincide, unless otherwise noted. Beams and joists shall be equally spaced between columns, unless otherwise noted.
- Stainless steel connectors, including hangers, nails, screws, bolls, & plates, shall be used for all pressure freaded woods that are ACQ-C (Alkaline Copper Qual Type C), ACQ-D Carbonate ACQ-C (Alkaline Copper Qual Type S), ACQ-D Carbonate CA-B (Copper Azole Types A and B), or as specifically recommended by pressure treated lumber manufacturer.
- 10. Material and equipment storage shall be on site and as directed by Owner.
- 11. Maintain premises and public properties free from accumulations of waste materials, debris and rubbish caused by operations.
- 12. After completion of work, Contractor shall remove all waste materials, rubbish, tools, and surplus materials and clean sight exposed surfaces. Construction site shall be organized and cleaned up by Contractor on a daily basis.
- 13. The Contractor shall restore to its original condition all site appurtenances damaged under this contract at no additional cost to the Owner.
- 14. All details, sections and notes shown on the drawings are intended to be typical and shall apply to similar situations elsewhere, unless specifically shown or noted otherwise.
- 15. Do not scale the drawings.
- 16. Dimensions are typically to rough framing, UNO.
- 17. Scales on drawings are in reference to the full size 22"x34" drawing sheet. For the 11"x17" format, reduce written scales by 50%.




DSC08359

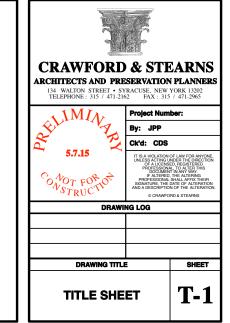

Window Restoration:

Selective Finishes Removal:

Generally N. I. C. at this level unless mandated by hazmat mitigation. Removal of bathroom vents & soffit is included per plan above.

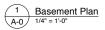



Stabilization & Restoration Plans for the Mohonk Preserve Testimonial Gateway New Paltz, New York DRAWING TITLE

Basement Plan

2H1M/A

5.7.15


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PHONE. (315) 471-2162 • BAX. (315) 471-2065

- General Notes:

 1. These plans and elevations are based on a facsimile of the original drawings by
 "JAS E: WARE & SONS ARCHITECTS 1170 BROADWAY, NYC"
 provided by the Mohnek Preserve. They are not known to be a-built drawings.

 2. Stone balconies at observatory level & ground level buttresses were modified from that shown in historic drawings.

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 11"x17" format, reduce written scales by 50%.

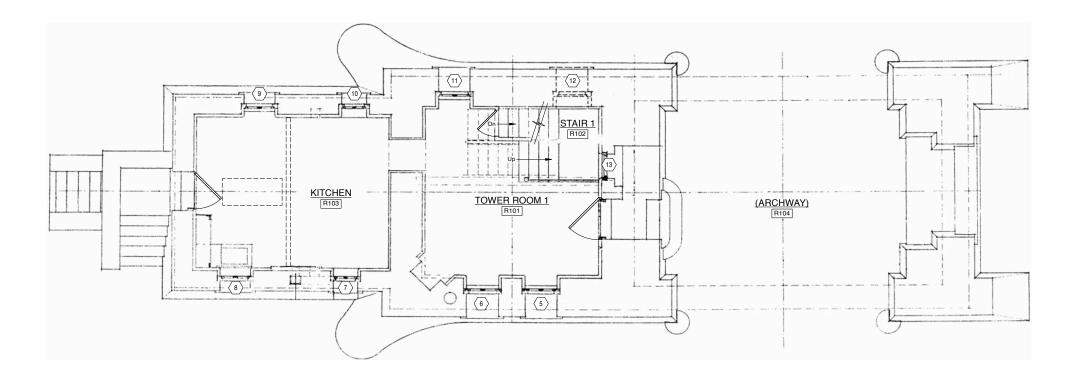

Window Restoration:

In general, remove gypsum/plaster board walls & ceilings, but not wooden framing, in all rooms. Leave related wooden framing in place.





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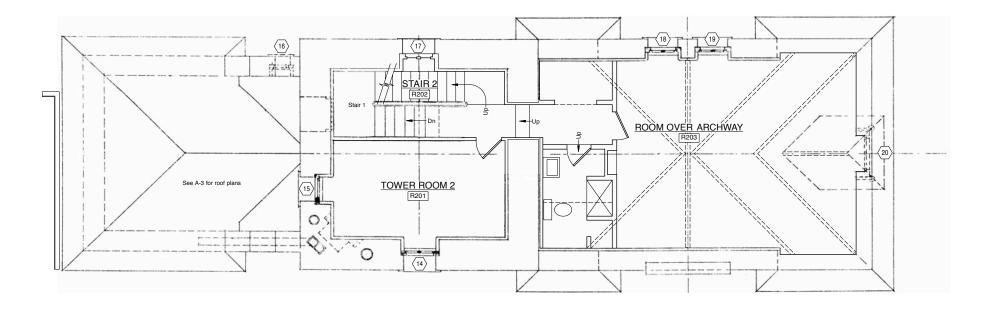
Stabilization & Restoration Plans for the Mohonk Preserve Testimonial Gateway New Paltz, New York

DRAWING TITLE

First Floor Plan







Window Restoration:

(14) through (20) at this level will be new clad wooden casement windows w/ "leaded" insulating glass, except (16), which will be repair of original. (14) (15) & (17) will also have clad fixed wooden transoms w/ leaded glass. See window schedule.

Remove gypsum/plaster board walls & false ceiling in Tower Room. Leave related wooden framing & beadboard in place. Remove gypsum/plaster board walls & ceiling in Room Over Archway.





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Stabilization & Restoration Plans for the Mohonk Preserve Testimonial Gateway New Paltz, New York


DRAWING TITLE


Second Floor Plan

REVISION DATES





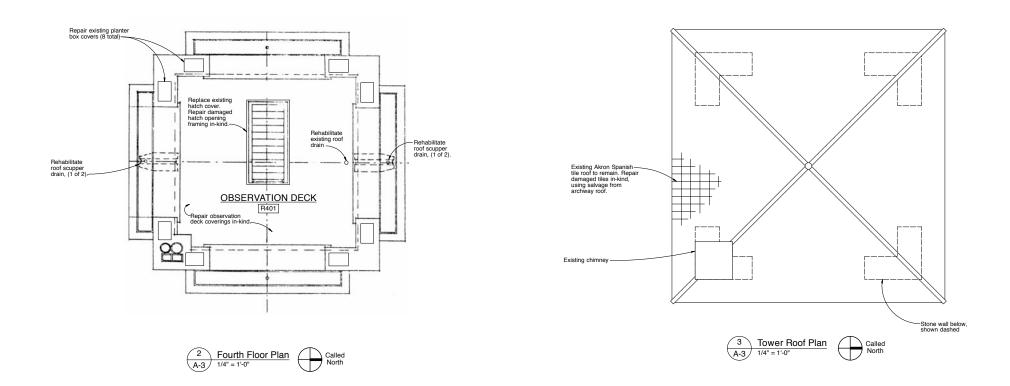

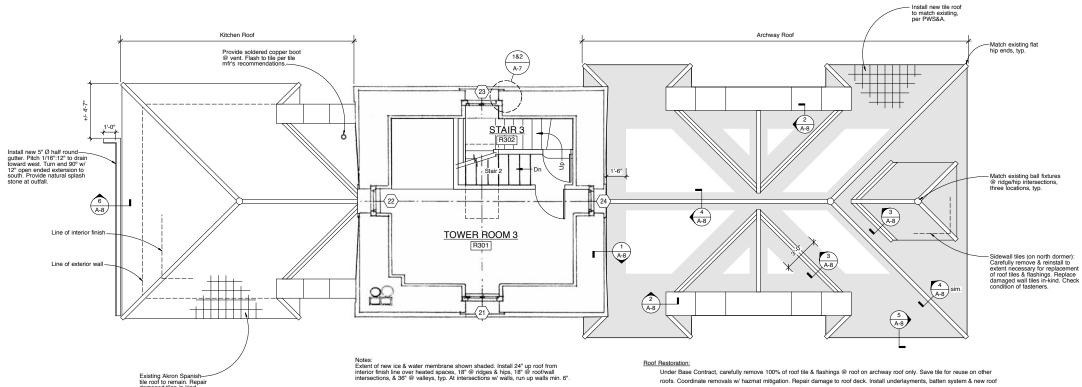

Ridge, hip & valley details will all be standard Ludowici tile details, adapted for batten system installation, similar to details on A-8.

Third Floor Plan & Roofs

A-3 1/4" = 1'-0"

Called North

Under Base Contract, carefully remove 100% of roof tile & flashings @ roof on archway roof only. Save tile for reuse on other roofs. Coordinate removals w/ hazmat mitigation. Repair damage to roof deck. Install underlayments, batten system & new roof tile & copper flashings in historic configuration per details. At kitchen & tower roofs, remove existing damaged tiles. Install tiles salvaged from archway roof. Replace damaged flashings in-kind.

At observation deck level, clean out & repair drainage scuppers. Repair membrane as needed. Install new wooden hatch & copper cover in historic configuration. Reuse existing hinges, isolated from dissimilar metals for galvanic protection. See Alternates.

Window Restoration:

(21),(22)&(24)at this level will be new clad wooden casement windows & clad fixed wooden transoms.

23 will be a new clad wooden casement window. All units will have leaded glass. See window schedule.

Selective Finishes Removal:

Remove all gypsum & plaster board finishes, & false ceiling. Leave related wooden framing & ferro concrete partitions in place.

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Stabilization & Restoration Plans for the Mohonk Preserve Testimonial Gateway New Paltz, New York

Third, Fourth & Tower Roof Plans





1 Building Section Looking West 3/16" = 1'-0"

2 Building Section Through Archway Looking South 3/16" = 1'-0"

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Stabilization & Restoration Plans for the Mohonk Preserve Testimonial Gateway New Paltz, New York

DRAWING TITLE

Building Sections






1 East Elevation NTS



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East & North

Elevations

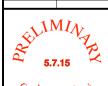


North Elevation
A-5 NTS

Stabilization & Restoration Plans for the Mohonk Preserve Testimonial Gateway New Paltz, New York

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West & South Elevations



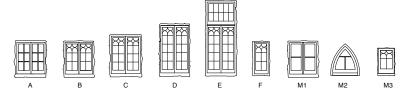

Window Types

Window Notes

- Removal of existing windows shall be by installer of new windows.
- 2. Masonry openings are approximate, & not measured. All dimensions & conditions must be verified in the field.
- 3. Single line muntins shown here are intended to represent leaded caming. Lead caming light patterns shall be as shown on elevations & window types.
- 4. New window units shall be Marvin Clad Ultimate Casement/Push out Casement w/ insulated Low E glass. See elevations for units w/ transoms.
- 5. Caming shall be 12mm wide flat natural finish soldered lead to match historic original (window #16). Install caming on #1 & #2 glass surfaces, typ.
- 6. Two new basement units (type A windows) shall have clad 5/8" muntins w/ spacer bars. See schedule.
- 7. Provide 1 1/2" clad casings, u.n.o.
- 8. Bottom rail of all new sash shall be 3 1/2" high.
- 9. All cladding shall be "Medium Bronze" color, factory finish.
- 10. Interiors shall be non-finger jointed Pine w/ factory primer.
- 11. New units shall include sash & frame, without nailing flanges.
- 12. Provide wood framed bronze screens, factory primed.

"Kitchen" Door: Existing door is a replacement & will remain in place. Door shown here is original design, & is NIC.

Basement Door

Tower Room 1 to Basement

Maintain in place

Tower Room 2 Door


Door Types

"Arch" Door

2nd Floor Bathroom Door

Remove

- 13. Standard 4 9/16" jambs.
- 14. Window latch shall be classic push-out hardware system. All hardware to be dark bronze color.
- 15. Provide complete shop drawings of all new windows for approval.
- 16. Historic original interior casings shall be carefully removed & reinstalled on new window units per detail. Replicate damaged & deteriorated original casings exactly.

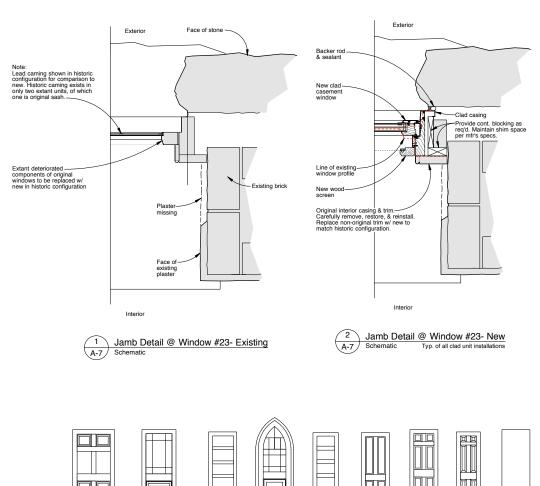

Room	Existing vs. New	Туре	Masonry Op'g (to be field verified)	Muntins/Caming		Remarks				
Basement										
1	New	А	2'-8" x 3'-1 3/4"	SDL		5/8" muntins, ogee. Bathroom vents to be removed. Relocation of existing bathroom vents to window #4 is N.I.C.				
2	Existing	M1		Existin	g wood	Casement, 2 pane x 2. Repair & paint. Under Alternate 4, replace sash & accommodate oil pipe penetrations.				
3	New	Α		SDL		5/8" muntins, ogee. Remove non-historic frame. Prep for new.				
4	Existing	M1	†	Existing wood		Casement, 2 pane x 2 csmt. Repair & paint. Accommodate future relocated bathroom vents. Under Alternate 4, replace sa				
First Floor										
5	New	E	2'-8" x 6'-5"	Lead (Caming					
6		E	2'-8" x 6'-5"							
7		F	1'-6" x 2'-11"			Under Alternate	4, replace sash in historic design.			
8		С	2'-8" x 3'-6"							
9		С	2'-8" x 3'-6"							
10		В	2'-7 1/2" x 2'-11 1/4"			,				
11		D	2'-7 1/4" x 4'-5"							
12	•	D	2'-7 1/4" x 4'-5"		,	Safety glazing i	required.			
13	Existing	Existing M2		Existing wood		Lancet. Restore extant frame & sash in-kind.				
Second Floor	•	•								
14	New	E	2'-7 1/4" x 6'-6"	Lead Caming						
15	New E		2'-7 1/4" x 6'-6"	1						
16	Existing	Existing M3		Existing Lead Caming		Casement w/ le	ead caming. Restore extant frame & sash in-kind.			
17	New E		2'-7 1/4" x 6'-6"	Lead Caming		Safety glazing required.				
18		D	2'-7 1/4" x 4'-5"							
19		D	2'-7 1/4" x 4'-5"							
20	•	С			,	3" casing. Wind	low installed in wood framed wall.			
Third Floor										
21	New E		2'-8" x 6'-6"	Load	Caming					
22	ivew	E	2'-8" x 6'-6"	Leau	Jaming					
23		В	2'-7 1/2" x 2'-11 1/4"							
23	 	E	2'-8" x 6'-6"		<u> </u>	Carafullu rama	ve existing leaded transom. Give to Owner.			

No.	Room	Floor	Base	Walls				Ceiling	Ceiling Height	Remarks	
				North	East	South	West	1			
Base	ment	•		•			•				
RB01	Tower Bsmt.								9'-6 1/2"	See selective finishes removal notes on	all plan drawings, typ
RB02	Stair B								8'-8" (landing)		
RB03	Kitch. Bsmt.								9'-0 3/4"		
RB04	Areaway									*	
First	Floor			•							
R101	Tower Room 1								9'-4 1/2"	See selective finishes removal notes on	all plan drawings, typ
R102	Stair 1								6'-2 3/4" & 7'-6" (landings)		
R103	Kitchen								8'-10 1/2"		
R104	Archway									†	
Seco	nd Floor										
R201	Tower Room 2								14'-7 1/4"	See selective finishes removal notes on	all plan drawings, typ
R202	Stair 2								9'-3 3/4" (landing)		
R203	Rm Over Archway								10'-7" (ridge)		
										†	
Third	Floor										
R301	Tower Room 3								14'-8"	See selective finishes removal notes on	all plan drawings, typ
R302	Stair 3								13'-2 1/4" (lower landing)		
										•	
Four	th Floor			•	•		•				
R401	Observation Deck								-		

General N

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Stabilization & Restoration Plans for the Mohonk Preserve Testimonial Gateway New Paltz, New York


DD AWING TITLE

Window & Room Rehabilitation Schedules

REVISION DATES



PROJECT #: 1502 BY: CKD: CDS DATE: May, 2015

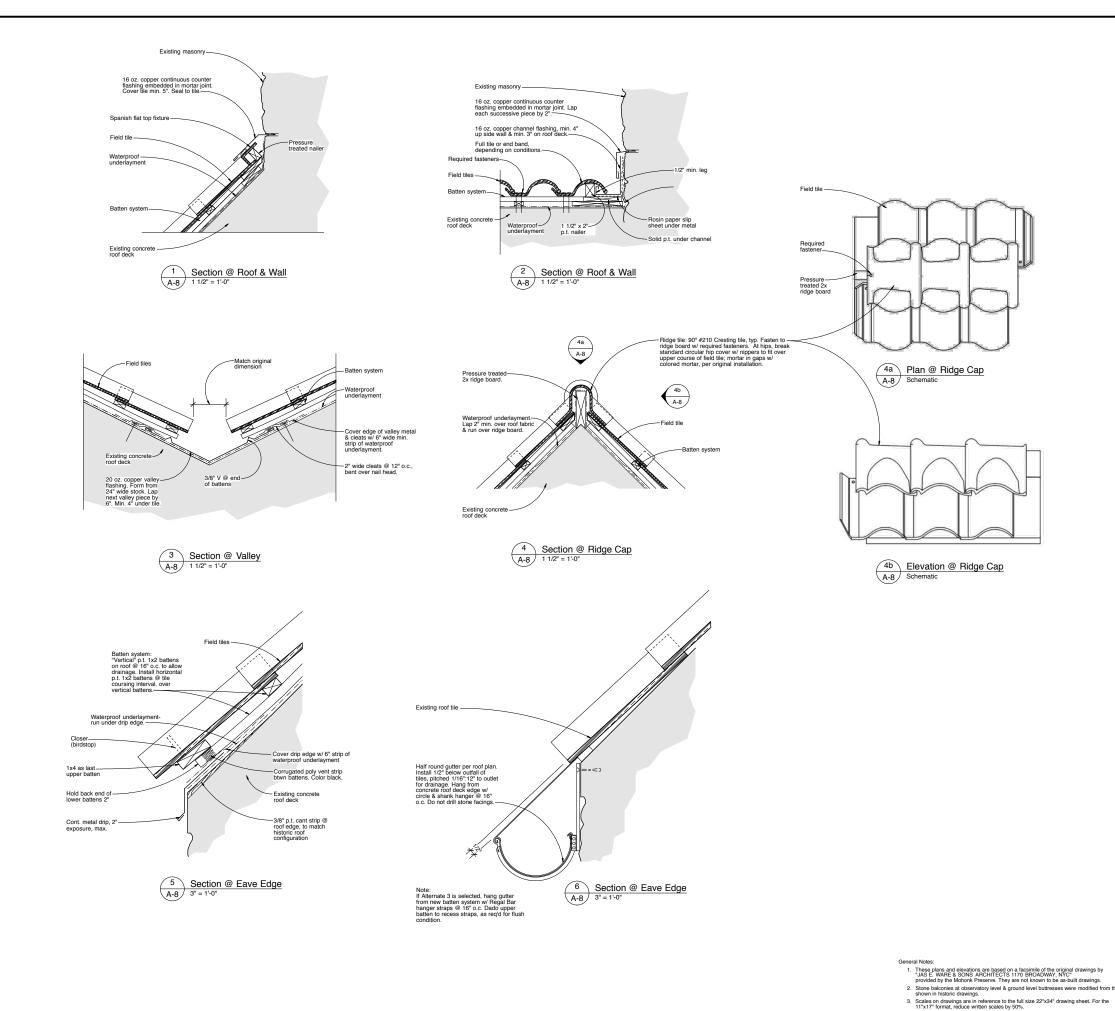

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Stabilization & Restoration Plans for the Mohonk Preserve Testimonial Gateway New Paltz, New York

DRAWING TITLE

Roof Details

REVISION DATES

ST.15 5.7.15

DATE: May, 2015